

THROUGH PENETRATION FIRESTOP SCHEDULE



- A. THIS SCHEDULE IDENTIFIES REQUIREMENTS FOR ACCEPTABLE THROUGH PENETRATION FIRESTOPS BASED ON BARRIER TYPE, BASIS OF BARRIER CONSTRUCTION, AND PENETRANT TYPE. THIS IS A STANDARD THROUGH PENETRATION FIRESTOP SCHEDULE. SOME BARRIERS AND/OR PENETRANT TYPES MAY NOT APPEAR ON THE DRAWINGS.
- B. THROUGH PENETRATION FIRESTOPS ARE NOT REQUIRED FOR FLOOR PENETRATIONS CONTAINED TOTALLY WITHIN A RATED SHAFT ENCLOSURE.
- C. FOR EACH PENETRATION, SELECT A THROUGH PENETRATION FIRESTOP BASED ON ACTUAL FIELD CONDITIONS, WHICH INCLUDE BUT ARE NOT LIMITED TO PENETRATION SIZE, PENETRATION SHAPE, PENETRANT MATERIAL(S), QUANTITY OF PENETRANTS PER PENETRATION, AND LOCATION(S) OF PENETRANT(S) WITHIN PENETRATION.
- D. NOMENCLATURE OF UL CLASSIFIED FIRESTOP ASSEMBLIES USED IN THIS SCHEDULE IS IDENTICAL TO THAT USED IN CATALOGS OF APPROVED FIRESTOP MANUFACTURERS (SEE DIVISION 15) AND IN UNDERWRITERS LABORATORIES "FIRE RESISTANCE DIRECTORY."

RATED BARRIER		FIRESTOP ASSEMBLY REQUIREMENTS		PENETRANT TYPE						
TYPE	BASIS OF CONSTRUCTION			NO PENETRANTS	METALLIC, UNINSULATED PIPE OR TUBING (EX. COPPER, IRON, STEEL) (NOTE 14)	NONMETALLIC, UNINSULATED PIPE OR TUBING (EX. PVC, PP, CPVC, GLASS, FRPP)	INSULATED PIPES (EX. COPPER, IRON PLASTIC, STEEL) IN SYSTEMS OPERATING BETWEEN 32°F AND 122°F (NOTE 1)	INSULATED PIPES (EX. COPPER, IRON PLASTIC, STEEL) IN SYSTEMS OPERATING BELOW 32°F OR ABOVE 122°F (NOTE 2)	METAL DUCT (NOTE 3)	RECESSED DEVICES (NOTE 4)
WALL	WOOD STUDS & GYPSUM WALLBOARD (U300 SERIES)	UL CLASSIFIED SERIES	SINGLE PENETRANT	W-L-0000 SERIES OR NOTE 5	W-L-1000 SERIES	W-L-2000 SERIES	W-L-5000 SERIES	W-L-5000 SERIES	W-L-7000 SERIES	W-L-7000 SERIES NOTE 8
			MULTIPLE PENETRANTS		W-L-8000 SERIES (NOTE 6)		W-L-8000 SERIES (NOTE 6)	W-L-8000 SERIES (NOTE 6)	N/A	
		F RATING		EQUAL TO WALL RATING	EQUAL TO WALL RATING	EQUAL TO WALL RATING	EQUAL TO WALL RATING	EQUAL TO WALL RATING	EQUAL TO WALL RATING	EQUAL TO WALL RATING
		T RATING		NOTE 10	NOTE 10	NOTE 10	NOTE 10	NOTE 10	NOTE 10	NOTE 10
		EXCEPTIONS/ ADDED REQUIREMENTS		NONE	NOTE 13	NOTE 13	NONE	NOTE 7	NONE	NONE
WALL	METAL STUDS & GYPSUM WALLBOARD (U400 SERIES)	UL CLASSIFIED SERIES	SINGLE PENETRANT	W-L-0000 SERIES OR NOTE 5	W-L-1000 SERIES	W-L-2000 SERIES	W-L-5000 SERIES	W-L-5000 SERIES	W-L-7000 SERIES	W-L-7000 SERIES NOTE 8
			MULTIPLE PENETRANTS		W-L-8000 SERIES (NOTE 6)		W-L-8000 SERIES (NOTE 6)	W-L-8000 SERIES (NOTE 6)	N/A	
		F RATING		EQUAL TO WALL RATING	EQUAL TO WALL RATING	EQUAL TO WALL RATING	EQUAL TO WALL RATING	EQUAL TO WALL RATING	EQUAL TO WALL RATING	EQUAL TO WALL RATING
		T RATING		NOTE 10	NOTE 10	NOTE 10	NOTE 10	NOTE 10	NOTE 10	NOTE 10
		EXCEPTIONS/ ADDED REQUIREMENTS		NONE	NOTE 13	NOTE 13	NONE	NOTE 7	NONE	NONE
WALL	POURED CONCRETE, CONCRETE BLOCK OR MASONRY (BLOCK & U900 SERIES) (ANY THICKNESS)	UL CLASSIFIED SERIES	SINGLE PENETRANT	W-J-0000 SERIES OR NOTE 5	C-AJ-1000 OR W-J-1000 SERIES	C-AJ-2000 OR W-J-2000 SERIES	C-AJ-5000 OR W-J-5000 SERIES	C-AJ-5000 OR W-J-5000 SERIES	C-AJ-7000 OR W-J-7000 SERIES	NOTE 8
			MULTIPLE PENETRANTS		C-AJ-8000 OR W-J-8000 SERIES (NOTE 6)		C-AJ-8000 OR W-J-8000 (NOTE 6)	C-AJ-8000 OR W-J-8000 (NOTE 6)	N/A	
		F RATING		EQUAL TO WALL RATING	EQUAL TO WALL RATING	EQUAL TO WALL RATING	EQUAL TO WALL RATING	EQUAL TO WALL RATING	EQUAL TO WALL RATING	EQUAL TO WALL RATING
		T RATING		NOTE 10	NOTE 10	NOTE 10	NOTE 10	NOTE 10	NOTE 10	NOTE 10
		EXCEPTIONS/ ADDED REQUIREMENTS		NONE	NOTES 12 & 13	NOTE 13	NONE	NOTE 7	NONE	NONE
FLOOR	POURED CONCRETE (ANY THICKNESS)	UL CLASSIFIED SERIES	SINGLE PENETRANT	C-AJ-0000 SERIES F-A-0000 SERIES OR NOTE 5	C-AJ-1000 OR F-A-1000 SERIES	C-AJ-2000 OR F-A-2000 SERIES	C-AJ-5000 OR F-A-5000 SERIES	C-AJ-5000 OR F-A-5000 SERIES	C-AJ-7000 OR F-A-7000 SERIES	NOTE 8
			MULTIPLE PENETRANTS		C-AJ-8000 OR F-A-8000 SERIES (NOTE 6)		C-AJ-8000 OR F-A-8000 (NOTE 6)	C-AJ-8000 OR F-A-8000 (NOTE 6)	N/A	
		F RATING		EQUAL TO FLOOR RATING, BUT NOT LESS THAN 1 HR	EQUAL TO FLOOR RATING, BUT NOT LESS THAN 1 HR	EQUAL TO FLOOR RATING, BUT NOT LESS THAN 1 HR	EQUAL TO FLOOR RATING, BUT NOT LESS THAN 1 HR	EQUAL TO FLOOR RATING, BUT NOT LESS THAN 1 HR	EQUAL TO FLOOR RATING, BUT NOT LESS THAN 1 HR	EQUAL TO FLOOR RATING, BUT NOT LESS THAN 1 HR
		T RATING		NOTE 11	NOTE 11	NOTE 11	NOTE 11	NOTE 11	NOTE 11	NOTE 11
		EXCEPTIONS/ ADDED REQUIREMENTS		NONE	NOTE 12	NONE	NONE	NOTE 7	NONE	NONE

NOTES

1. EXAMPLES OF SYSTEMS THAT OPERATE BETWEEN 32 DEGF AND 122 DEGF:

CHILLED WATER SUPPLY & RETURN DOMESTIC HOT WATER LESS THAN 122 DEGF
HEAT PUMP WATER SUPPLY & RETURN DOMESTIC HOT WATER RECIRCULATION LESS THAN 122 DEGF
DOMESTIC COLD AND TEMPERED WATER

2. EXAMPLES OF SYSTEMS OPERATING BELOW 32 DEGF OR ABOVE 122 DEGF:

STEAM SUPPLY & RETURN HEATING HOT WATER SUPPLY & RETURN
STEAM VENT HOT-CHILLED WATER SUPPLY & RETURN
CONDENSATE PUMP DISCHARGE GLYCOL HEATING HOT WATER SUPPLY & RETURN
BOILER BLOWDOWN DOMESTIC HOT WATER SUPPLY 140 DEGF
CRYOGENIC VENT DOMESTIC HOT WATER RECIRCULATION 140 DEGF
ENGINE GENERATOR EXHAUST

3. THIS SCHEDULE'S DATA APPLY ONLY TO PENETRATIONS WITHOUT DAMPERS. FOR DAMPERED PENETRATIONS, REFER TO SPECIFICATIONS. AT DAMPERS, DO NOT APPLY MATERIAL THAT IS NOT INCLUDED IN THE DAMPER'S CLASSIFICATION.

4. EXAMPLES OF RECESSED DEVICES:

MEDICAL GAS ZONE VALVES UNIT HEATERS
MEDICAL GAS OUTLETS FIRE FIGHTERS' PHONE
FIRE VALVE CABINETS FIRE EXTINGUISHER CABINET
FIRE HOSE CABINETS CENTRAL VACUUM OUTLETS

5. SEAL OPENING USING BARRIER'S ORIGINAL CONSTRUCTION.

6. WHERE A SERIES 8000 CLASSIFIED SYSTEM IS NOT AVAILABLE, INSTALL PENETRANTS SINGLY, AND PROVIDE SINGLE-PENETRANT SYSTEMS.

7. FOR SYSTEMS THAT OPERATE BELOW 32°F OR ABOVE 122°F, COMPLY WITH THE FOLLOWING ADDITIONAL REQUIREMENTS:

- A. PROVIDE TPFS SYSTEM USING INTUMESCENT ELASTOMERIC WRAP STRIP AS ITS FILL, VOID, OR CAVITY MATERIAL.
B. DO NOT USE SERIES 8000 PENETRATIONS. PROVIDE ONLY SINGLE PENETRATIONS.

8. WHERE UL CLASSIFIED SYSTEMS ARE NOT AVAILABLE FOR OTHER RECESSED DEVICES, MAINTAIN CONTINUITY OF RATED BARRIER CONSTRUCTION AROUND RECESS.

9. REQUIREMENTS FOR MEMBRANE PENETRATIONS AND THROUGH PENETRATIONS ARE IDENTICAL.

10. TEMPERATURE (T) RATINGS OF ASSEMBLIES IN WALLS MAY EQUAL ZERO.

11. TEMPERATURE (T) RATINGS OF ASSEMBLIES IN FLOORS SHALL EQUAL THE GREATER OF EITHER THE BARRIER RATING OR ONE HOUR EXCEPT AS FOLLOWS:

- A. AN ASSEMBLY'S T RATING MAY EQUAL ZERO WHEN THE PENETRANT ABOVE THE FLOOR PENETRATION IS CONTAINED AND LOCATED WITHIN THE CAVITY OF A WALL.

12. CLASSIFIED TPFS ASSEMBLY IS NOT REQUIRED WHEN ALL THE FOLLOWING CONDITIONS ARE MET:

- A. PENETRANT HAS A MAXIMUM NOMINAL DIAMETER OF 6-INCHES.
B. PENETRATION HAS A MAXIMUM AREA OF 144 SQUARE INCHES.
C. ANNULAR SPACE IS COMPLETELY FILLED WITH CONCRETE, GROUT, OR MORTAR THE FULL THICKNESS OF THE BARRIER.

13. OPENINGS ACCOMMODATING NONCOMBUSTIBLE CONDUITS, PIPES AND TUBES THROUGH SINGLE MEMBRANES WHICH ARE PART OF A FIRE RESISTANCE RATED WALL ASSEMBLY ARE PERMITTED WHEN:

- A. AGGREGATE AREA OF THE MEMBRANE OPENINGS DO NOT EXCEED 100 SQUARE INCHES FOR ANY 100 SQUARE FEET OF WALL AREA.

14. THIS COLUMN ALSO INCLUDES WIRES AND CABLES WITH STEEL JACKETS.

Partner In Charge	DSC
Project Engineer	CRB
Drawn By	CSL
Date Drawn	11-28-11
Revisions	
No. _____	Date _____
No. _____	Date _____
No. _____	Date _____
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No. _____	Date _____
No. _____	Date _____
No. _____	Date _____

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Project	PHRC LABORATORY 305 RENOVATION	Sheet Title
		PLUMBING SCHEDULES

JHS
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1812 LINCOLN STREET
THIRD FLOOR
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Project Number	922x06
Sheet	Of
P5.1	



PLUMBING FIXTURE SCHEDULE										
No	FIXTURE	ROUGH-IN CONNECTION					FIXTURE UNITS			REMARKS
		CW	HW	TEPID	SAN	VENT	CW	HW	SAN	
P-1	LAB SINK	1/2"	1/2"	—	1 1/2"	1 1/2"	1.0	1.0	2	INTEGRAL W/COUNTERTOP ①
P-2	EMERGENCY EYEWASH			1/2"						TEPID WATER ①
P-3	EMERGENCY EYEWASH/SHOWER	—	—	1"	2"	1 1/2"	—	—	1	TEPID WATER ①
P-4	ICE MAKER CONNECTION	1/2"	—	—	—	—	0.25	—	—	RECESSED

① REFER TO ARCHITECT/LABORATORY PLANNER DRAWINGS FOR MORE INFORMATION. PLUMBING FIXTURE SCHEDULE IS FOR ROUGH-IN SIZES ONLY.

LABORATORY EQUIPMENT SCHEDULE										
DESIGNATION	DESCRIPTION	ROUGH-IN CONNECTION								REMARKS
		CW	HW	SAN	VENT	AIR	VAC	GAS		
FH-1	FUME HOOD	1/2"	—	1 1/2"	1 1/2"	1/2"	3/4"	1/2"		①

① REFER TO ARCHITECT/LABORATORY PLANNER DRAWINGS FOR CONNECTION LOCATIONS AND MORE INFORMATION. LABORATORY EQUIPMENT SCHEDULE IS FOR ROUGH-IN SIZES ONLY.

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Project Engineer

CRB

Drawn By

CSL

Date Drawn

11-28-11

Revisions

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No. Date.

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No. Date.


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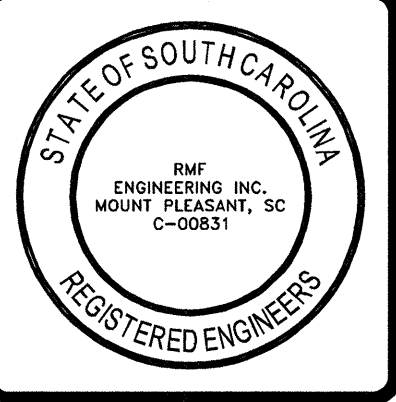
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Project

PHRC LABORATORY 305 RENOVATION

Sheet Title

PLUMBING SCHEDULES



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1812 LINCOLN STREET
THIRD FLOOR
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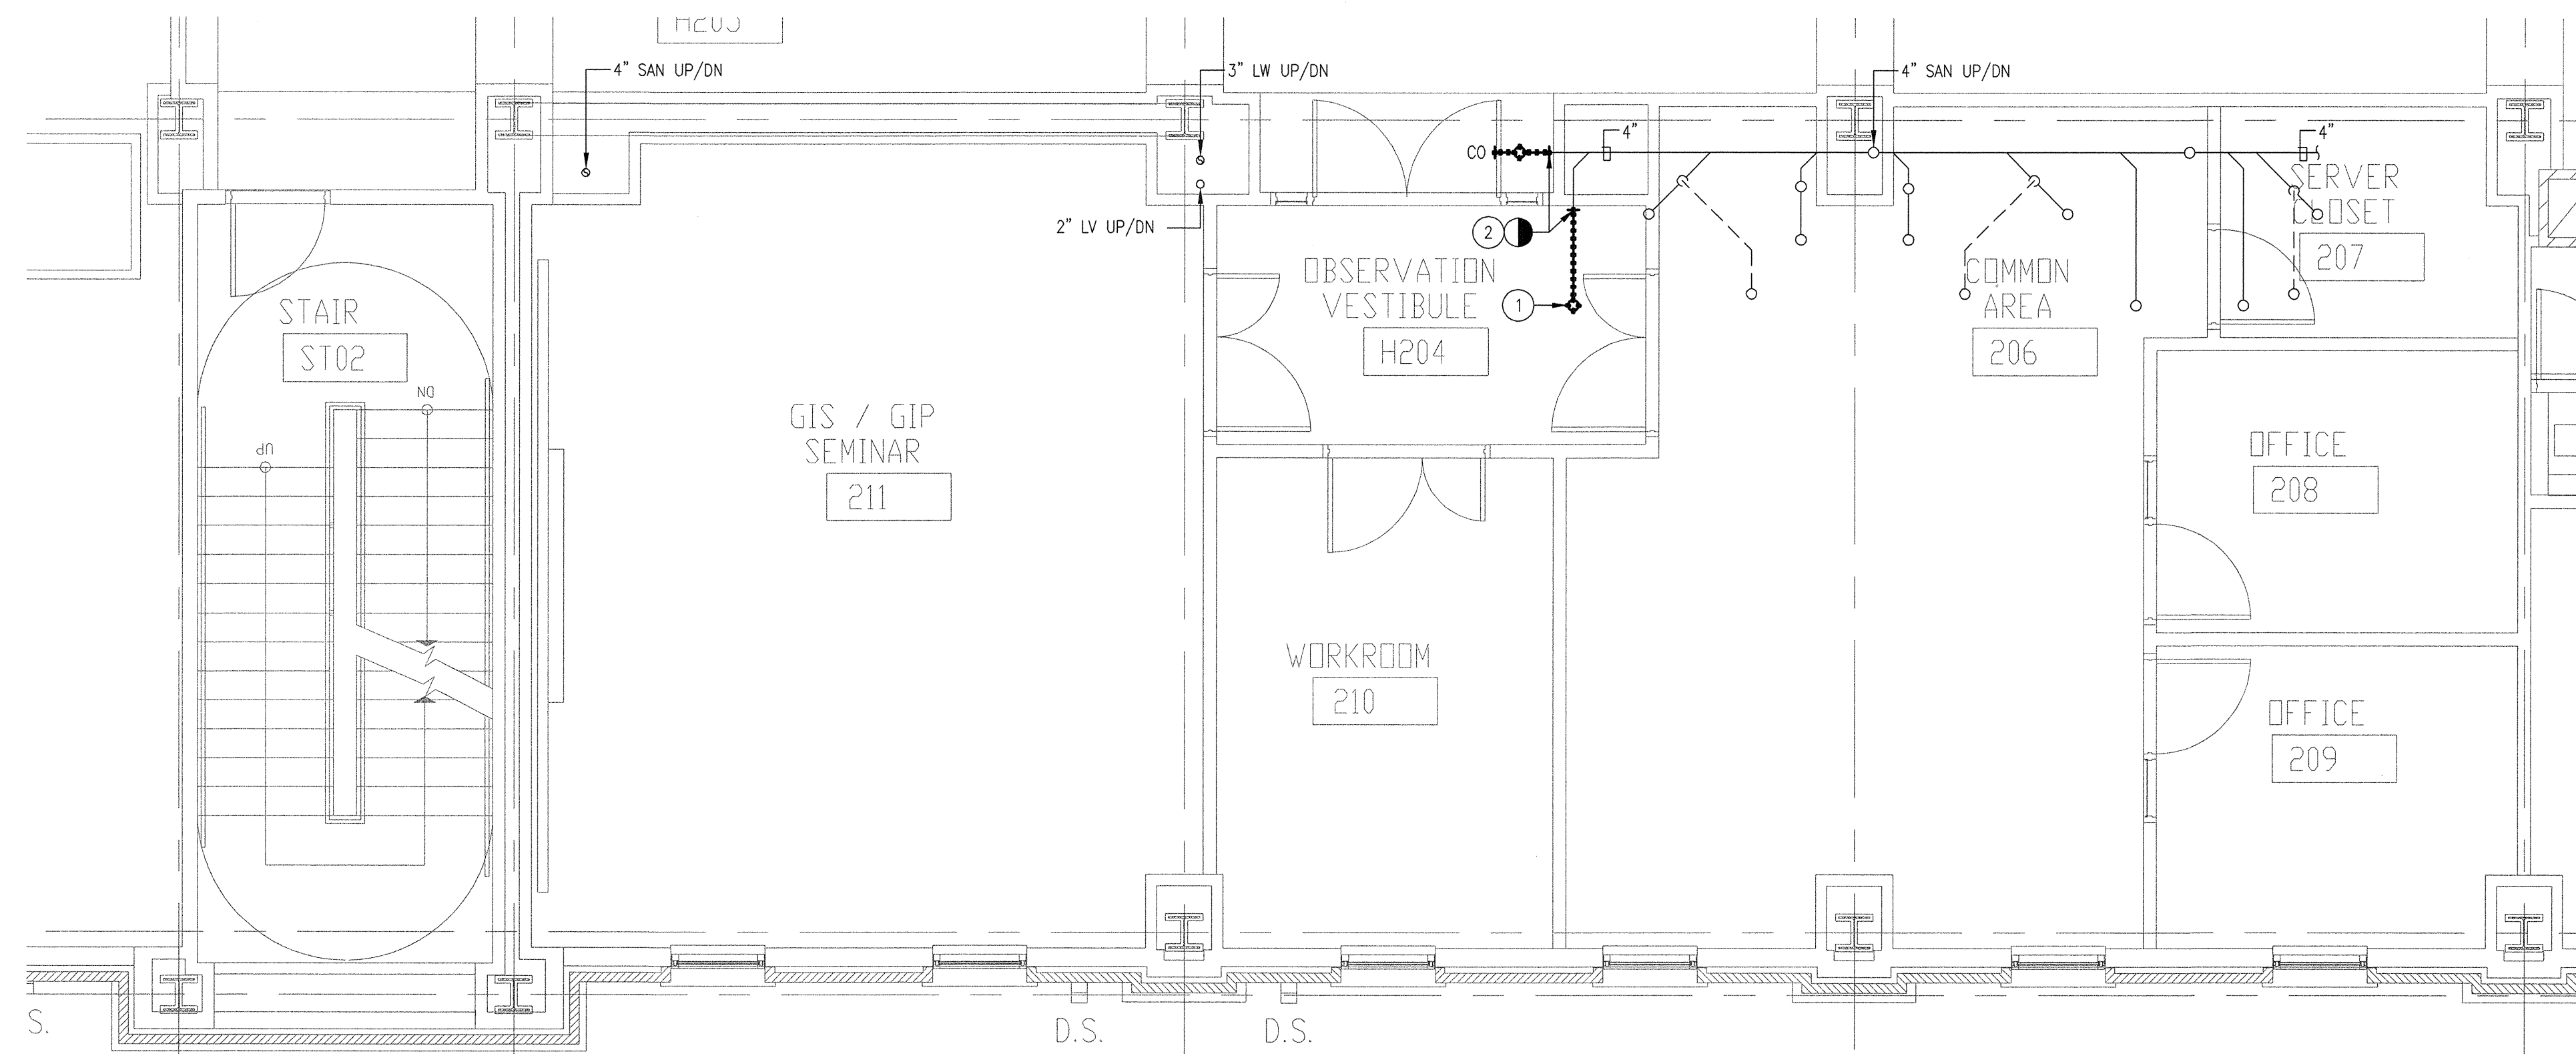
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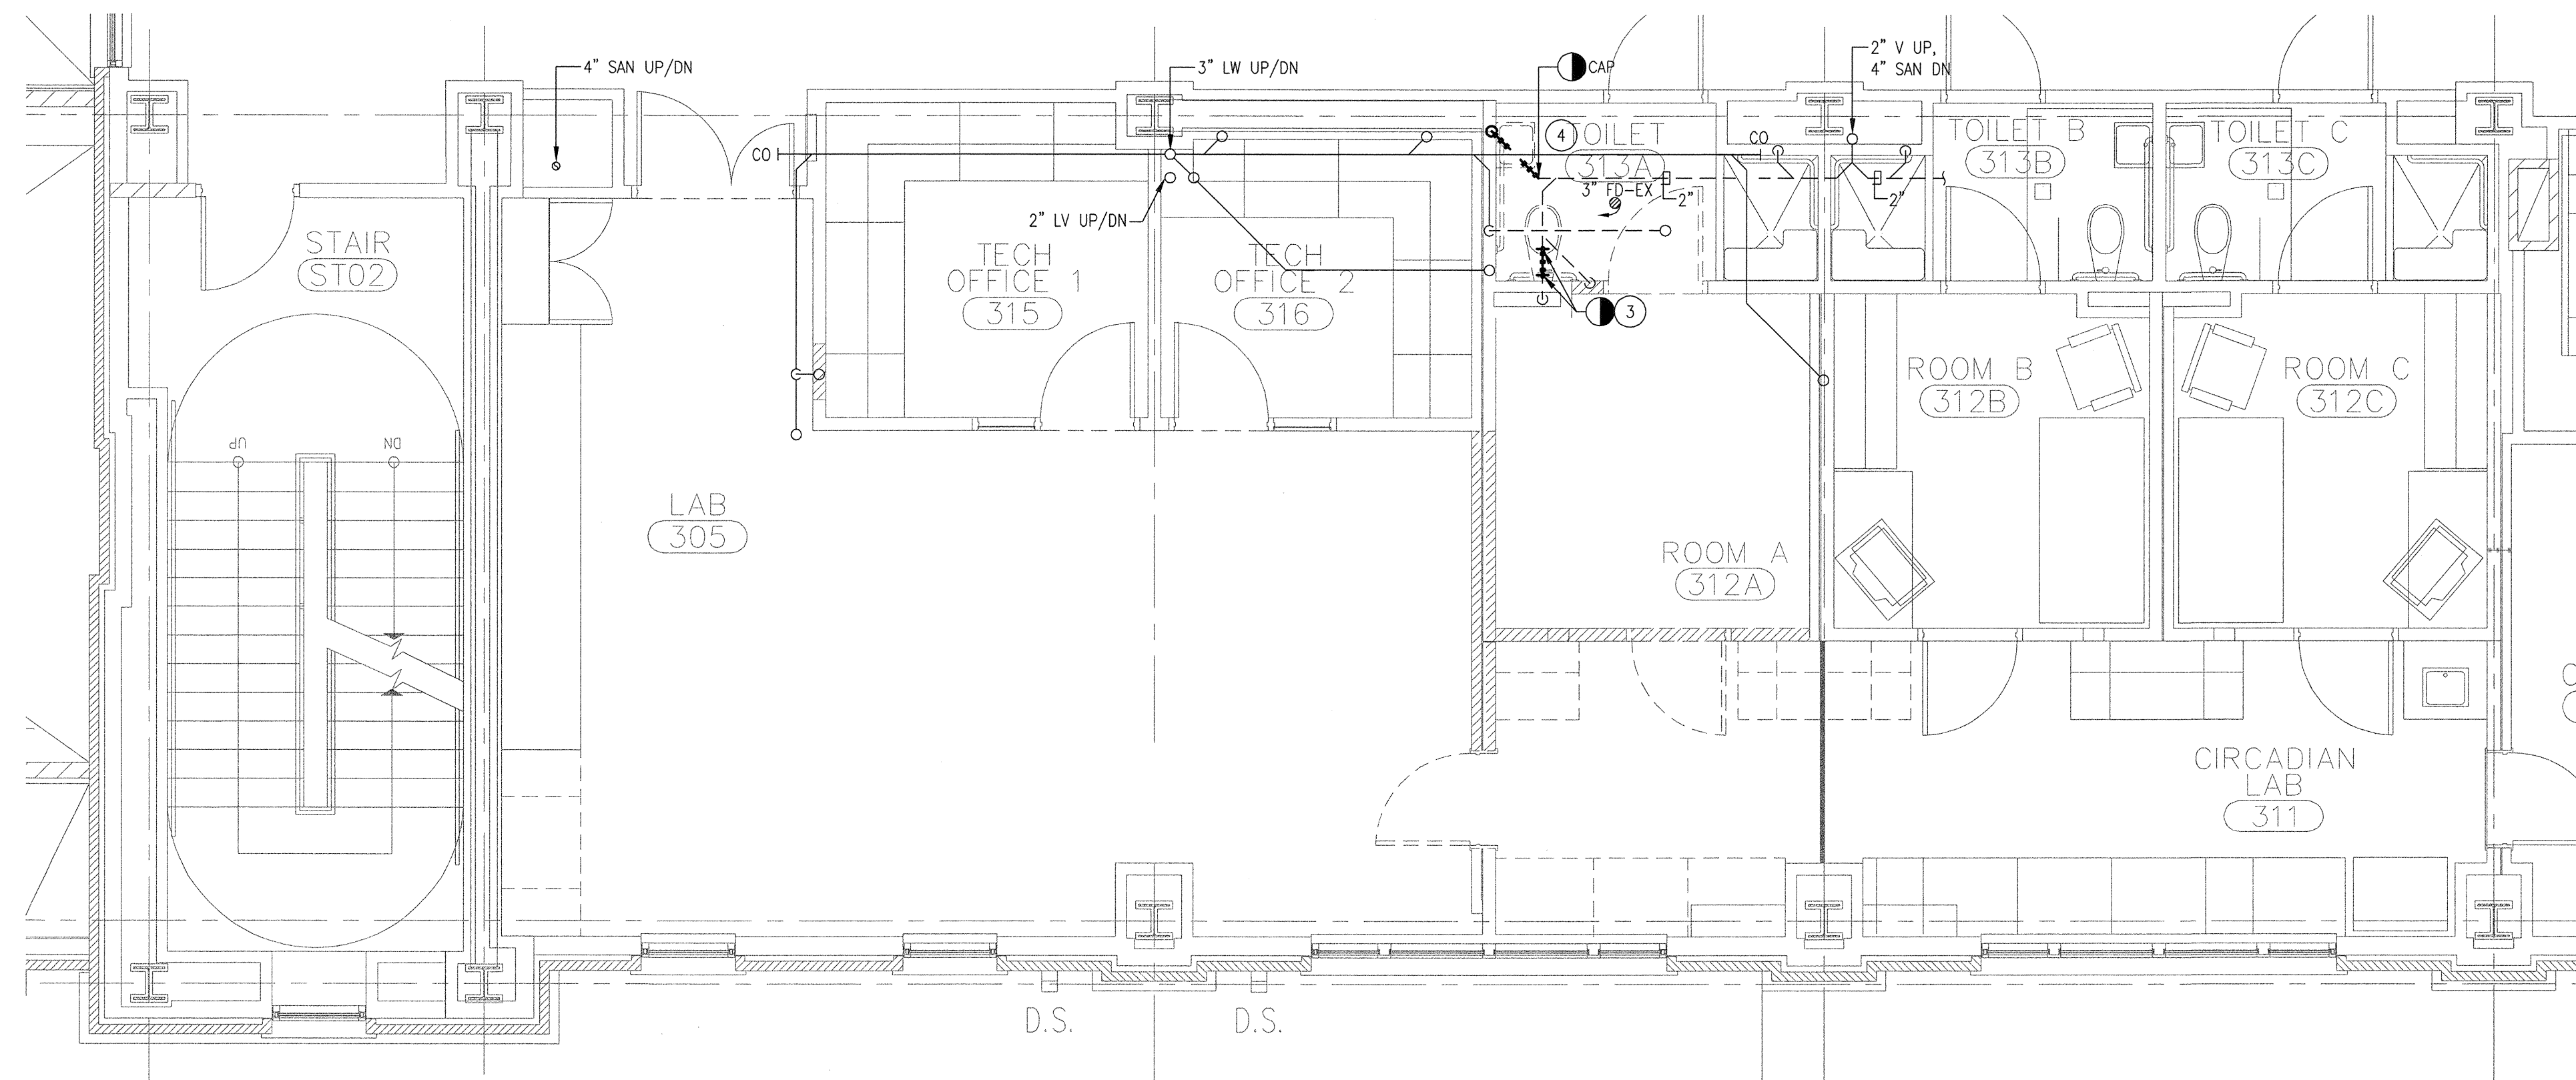
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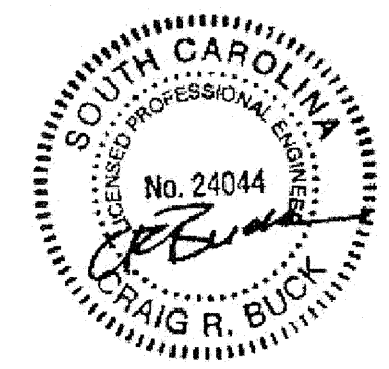
P5.2



PARTIAL SECOND FLOOR – DEMOLITION SANITARY/VENT
SCALE: 1/4"=1'-0"



PARTIAL THIRD FLOOR – DEMOLITION SANITARY/VENT
SCALE: 1/4"=1'-0"



GENERAL NOTES:

1. ALL OPENINGS IN THE SECOND FLOOR SLAB RESULTING FROM PIPE DEMOLITION SHALL BE PATCHED FLUSH TO MATCH EXISTING SLAB. REFER TO SPECIFICATIONS.
2. ALL OPENINGS IN THE THIRD FLOOR WALLS RESULTING FROM PIPE DEMOLITION SHALL BE PATCHED FLUSH TO MATCH EXISTING WALL. REFER TO SPECIFICATIONS.

DEMOLITION NOTES:

1. REMOVE SANITARY PIPING FLUSH TO THIRD FLOOR SLAB, CAP AND ABANDON IN PLACE.
2. REMOVE SANITARY PIPING TO EXISTING WALL AND CLEANOUT SHALL BE INSTALLED AT OPEN END OF SANITARY PIPING.
3. REMOVE EXISTING WATER CLOSET AND ALL ASSOCIATED SANITARY AND VENT FLUSH WITH WALL, CAP AND ABANDON IN PLACE. PATCH WALL FINISH TO MATCH EXISTING.
4. REMOVE EXISTING LAVATORY AND ALL ASSOCIATED SANITARY AND VENT. PATCH WALL FINISH TO MATCH EXISTING.

Partner In Charge

DSC

Project Engineer

CRB

Drawn By

CSL

Date Drawn

11-28-11

Revisions

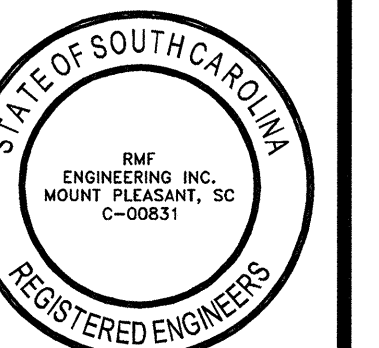
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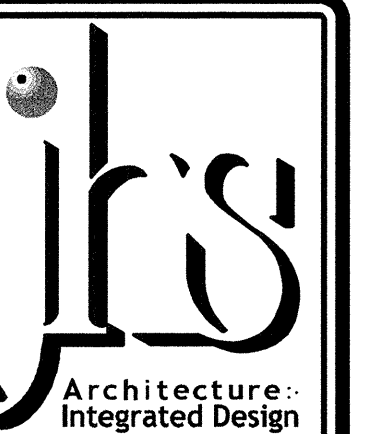
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Project
PHRC LABORATORY 305 RENOVATION

Sheet Title
SECOND/THIRD FLOOR
SANITARY/VENT DEMOLITION



1812 LINCOLN STREET
THIRD FLOOR
COLUMBIA, SC 29201-2310
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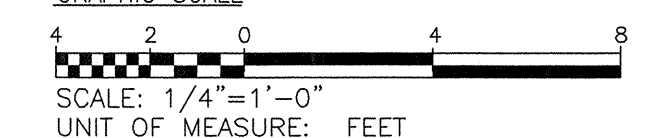
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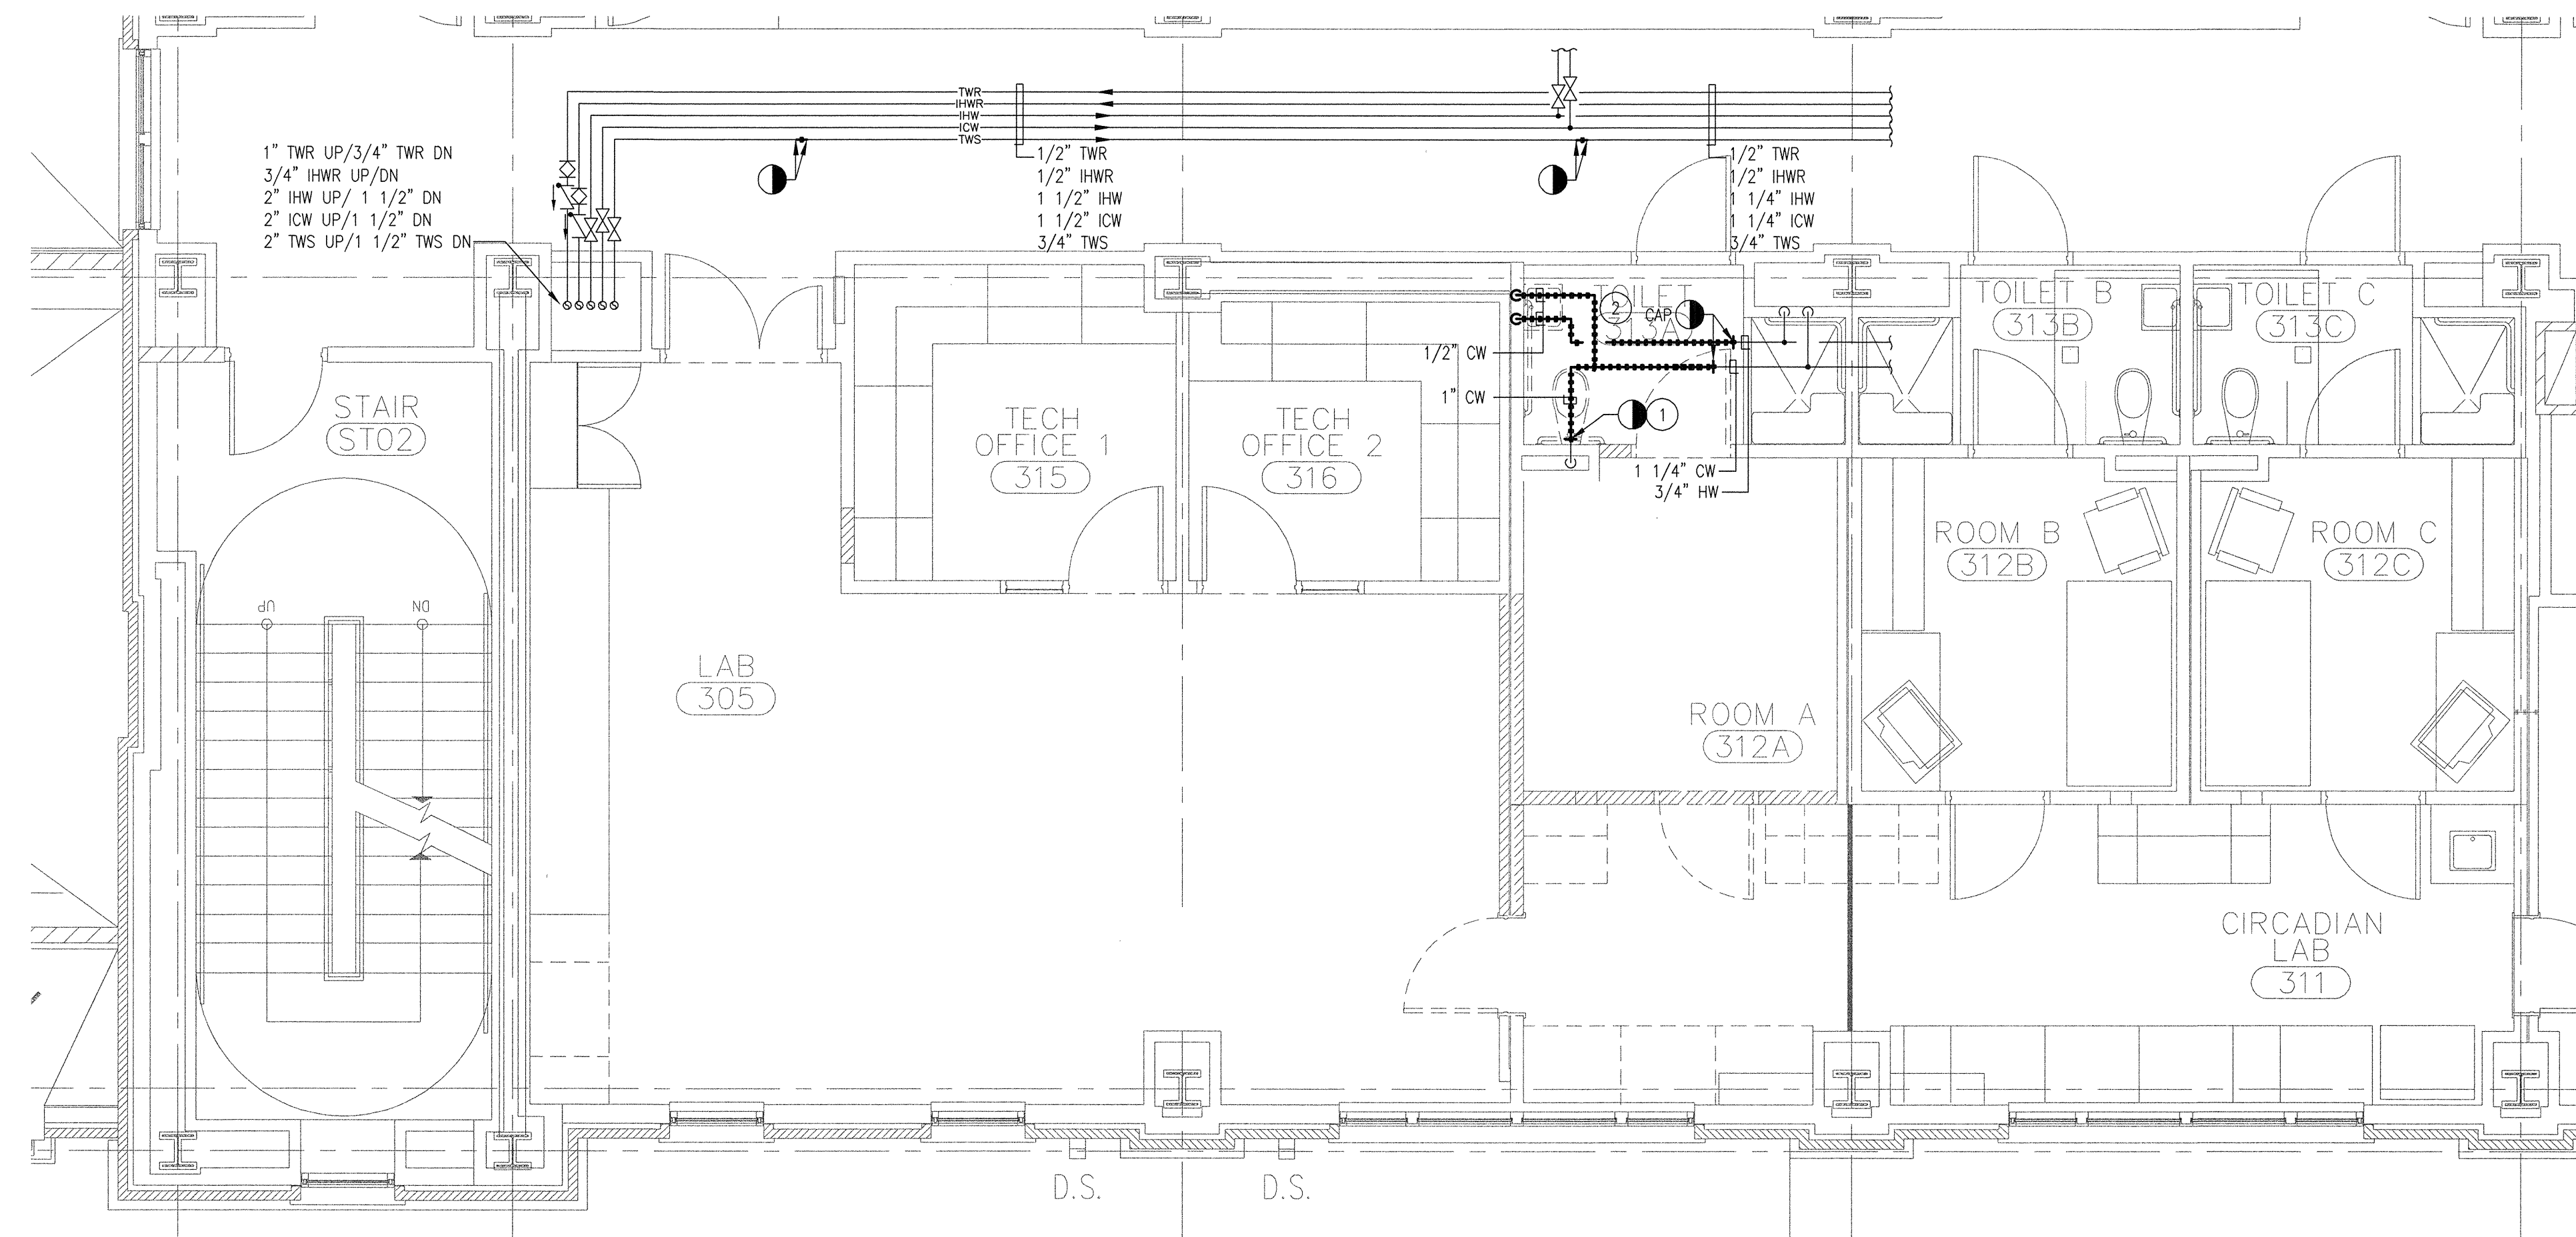
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GRAPHIC SCALE

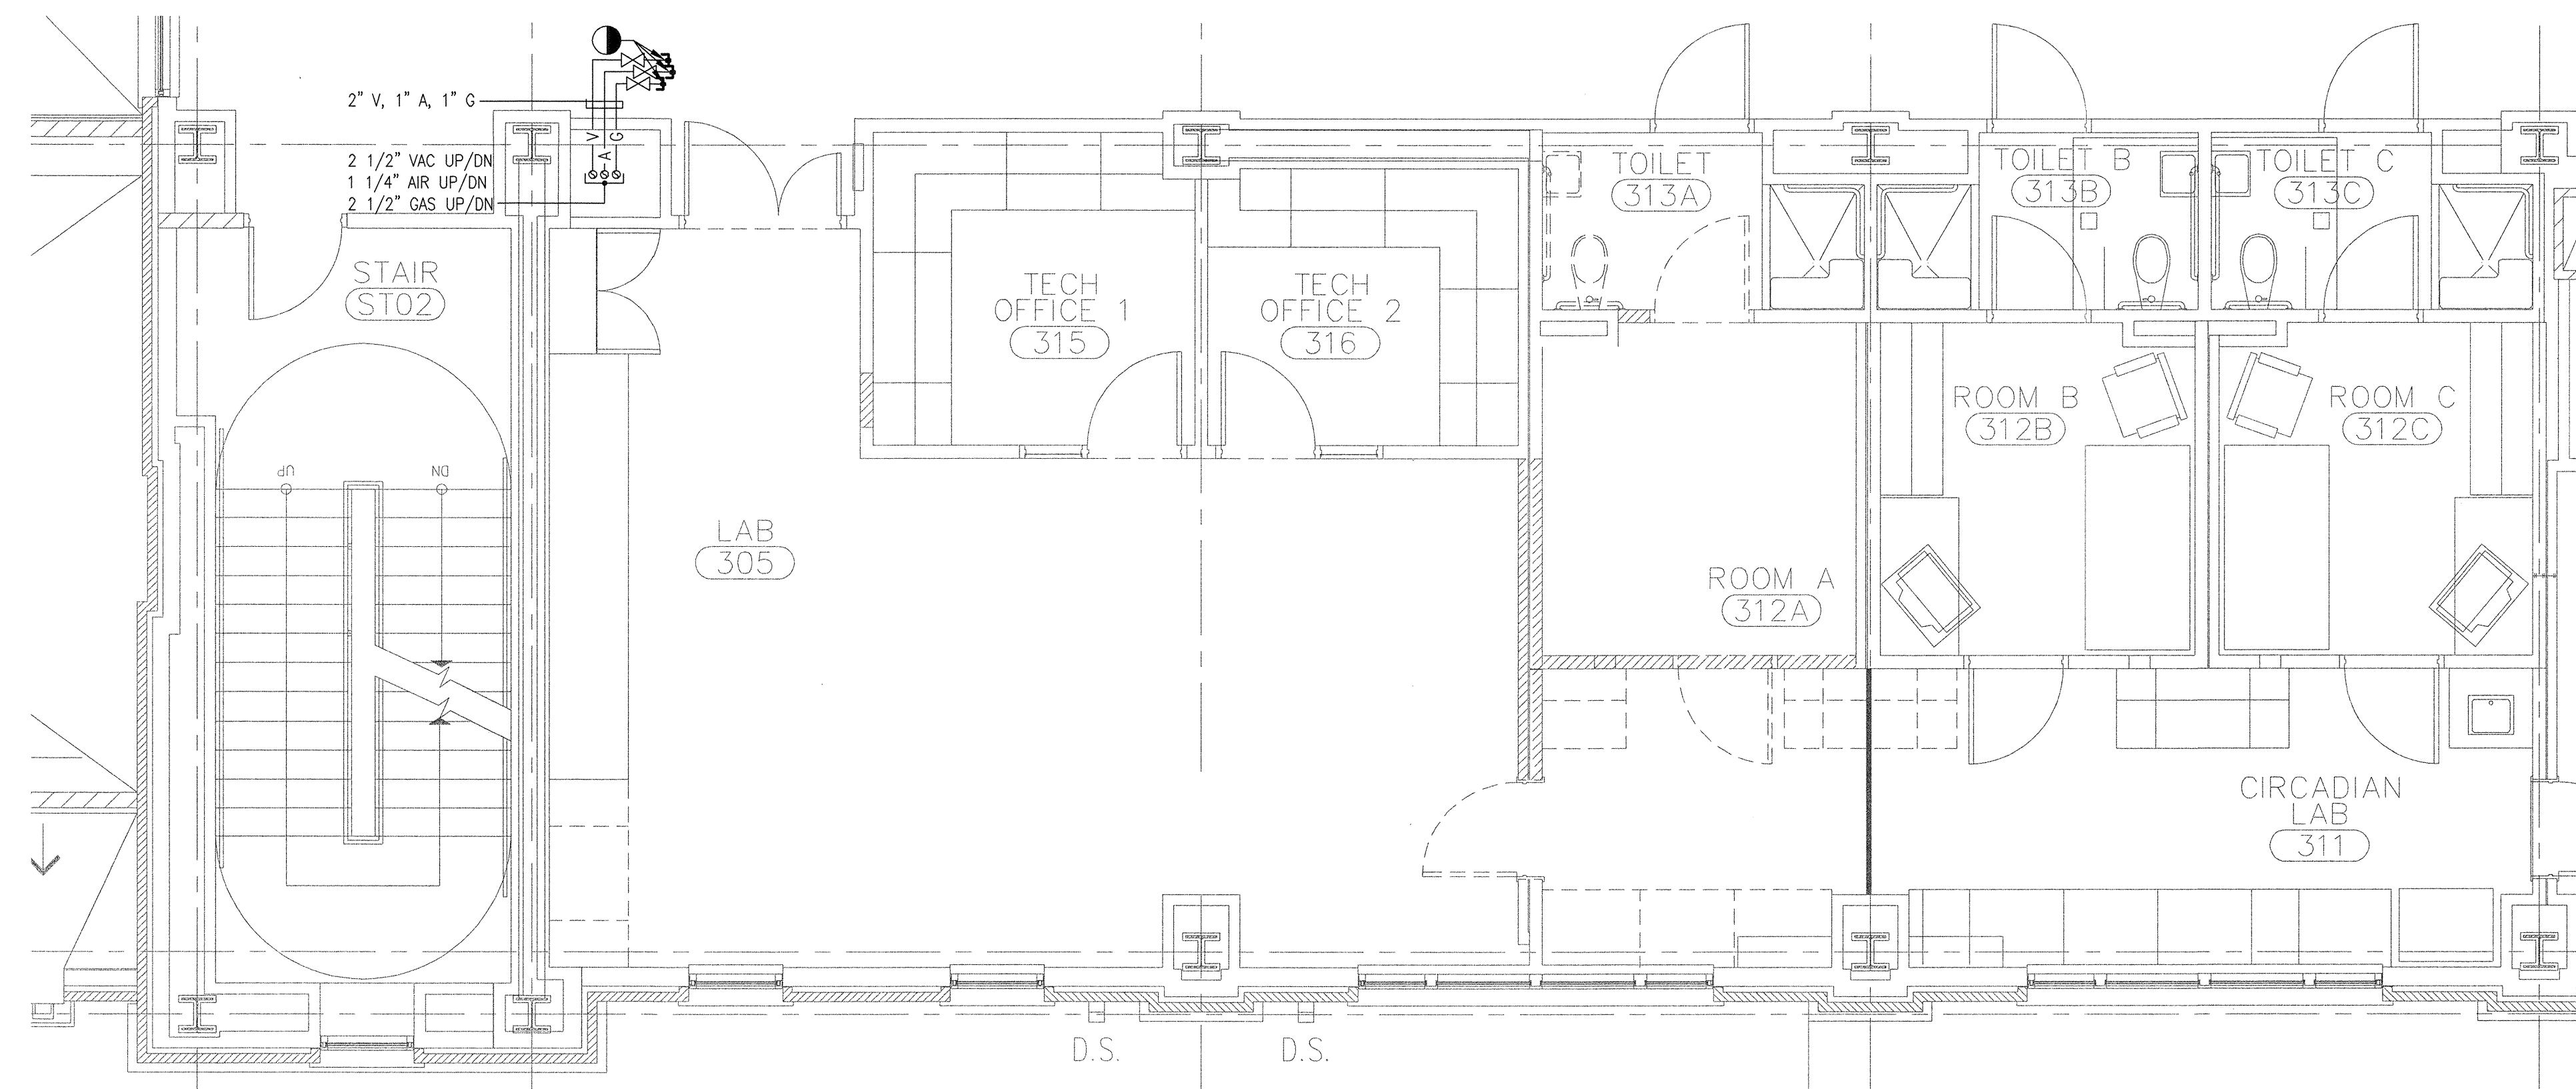


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UNIT OF MEASURE: FEET



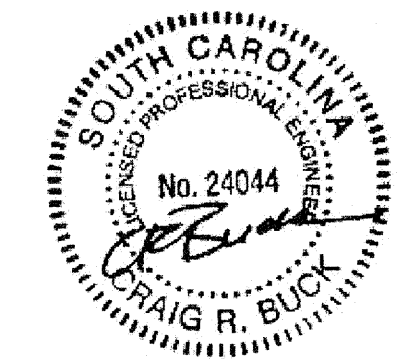
PARTIAL THIRD FLOOR — DEMOLITION DOMESTIC WATER

SCALE: 1/4"=1'-0"



PARTIAL THIRD FLOOR — DEMOLITION LAB GAS

SCALE: 1/4"=1'-0"



GENERAL NOTES:

1. ALL OPENINGS IN THE THIRD FLOOR WALLS RESULTING FROM PIPE DEMOLITION SHALL BE PATCHED FLUSH TO MATCH EXISTING WALL. REFER TO SPECIFICATIONS.

DEMOLITION NOTES:

1. REMOVE EXISTING WATER CLOSET AND ALL ASSOCIATED DOMESTIC WATER PIPING FLUSH WITH WALL, CAP AND ABANDON IN PLACE. PATCH WALL TO MATCH EXISTING.
2. REMOVE EXISTING LAVATORY AND ALL ASSOCIATED DOMESTIC WATER PIPING. PATCH WALL TO MATCH EXISTING.

Partner In Charge

DSC

Project Engineer

CRB

Drawn By

CSL

Date Drawn

11-28-11

Revisions

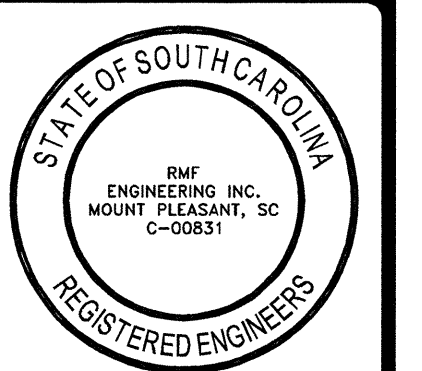
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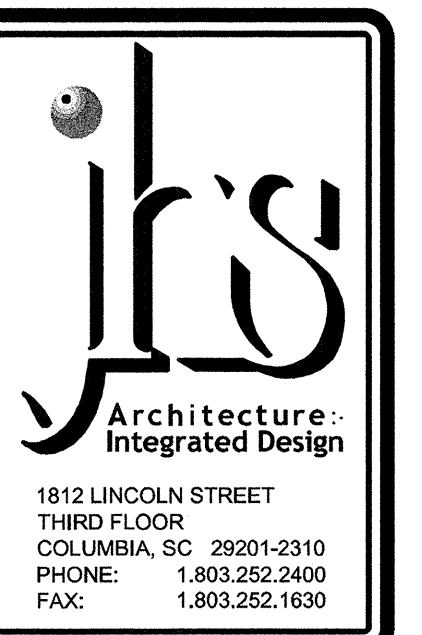
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Sheet Title
THIRD FLOOR DOMESTIC WATER
AND LABORATORY GAS DEMOLITION



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